



LEGEND:	
	APPLICATION BOUNDARY
	EXISTING PLANTING
	PROPOSED PLANTING


- NOTES:**
- CO-ORDINATES TO TM GRID.
  - ALL LEVELS IN METRES TO MAIN HEAD ORDNANCE DATUM.
  - ALL DIMENSIONS ARE IN mm. NO DIMENSIONS SHALL BE SCALED FROM THE DRAWINGS.
  - REFER TO THE LATEST VERSION OF DRAWING PE605-D027-038-004 FOR SUBSTATION LAYOUT.
  - THIS DRAWING IS PRODUCED FOR PLANNING PURPOSES ONLY. ALL DIMENSIONS AND REFERENCES GIVEN ARE FOR A GENERAL ARRANGEMENT AND SHOULD NOT BE USED AS PART OF DETAILED DESIGN. THIS DRAWING IS NOT FOR CONSTRUCTION.
  - CIVIL AND ELECTRICAL CALCULATIONS ARE TO BE CARRIED OUT AT THE DETAILED DESIGN STAGE AND TAKE INTO ACCOUNT SPECIFIC EXISTING SITE GRADING CONDITIONS.
  - SPECIFIC SWITCHGEAR AND BUILDING REQUIREMENTS ARE TO SUIT MANUFACTURERS SPECIFICATIONS AND TO BE EVALUATED AT THE DETAILED DESIGN STAGE.

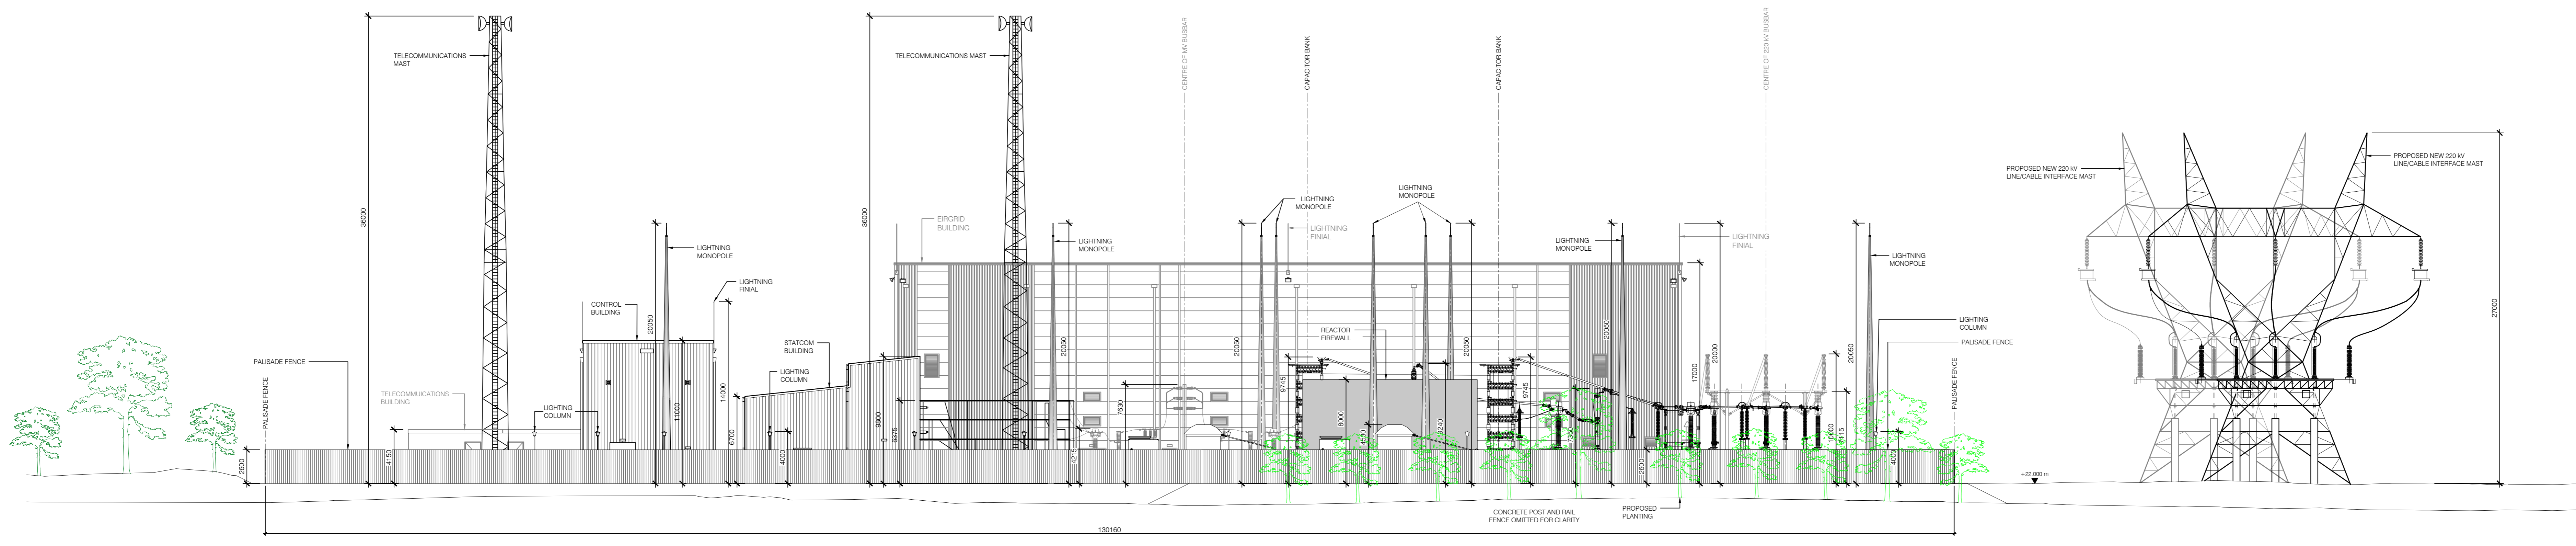


NORTH ELEVATION  
SCALE 1:200

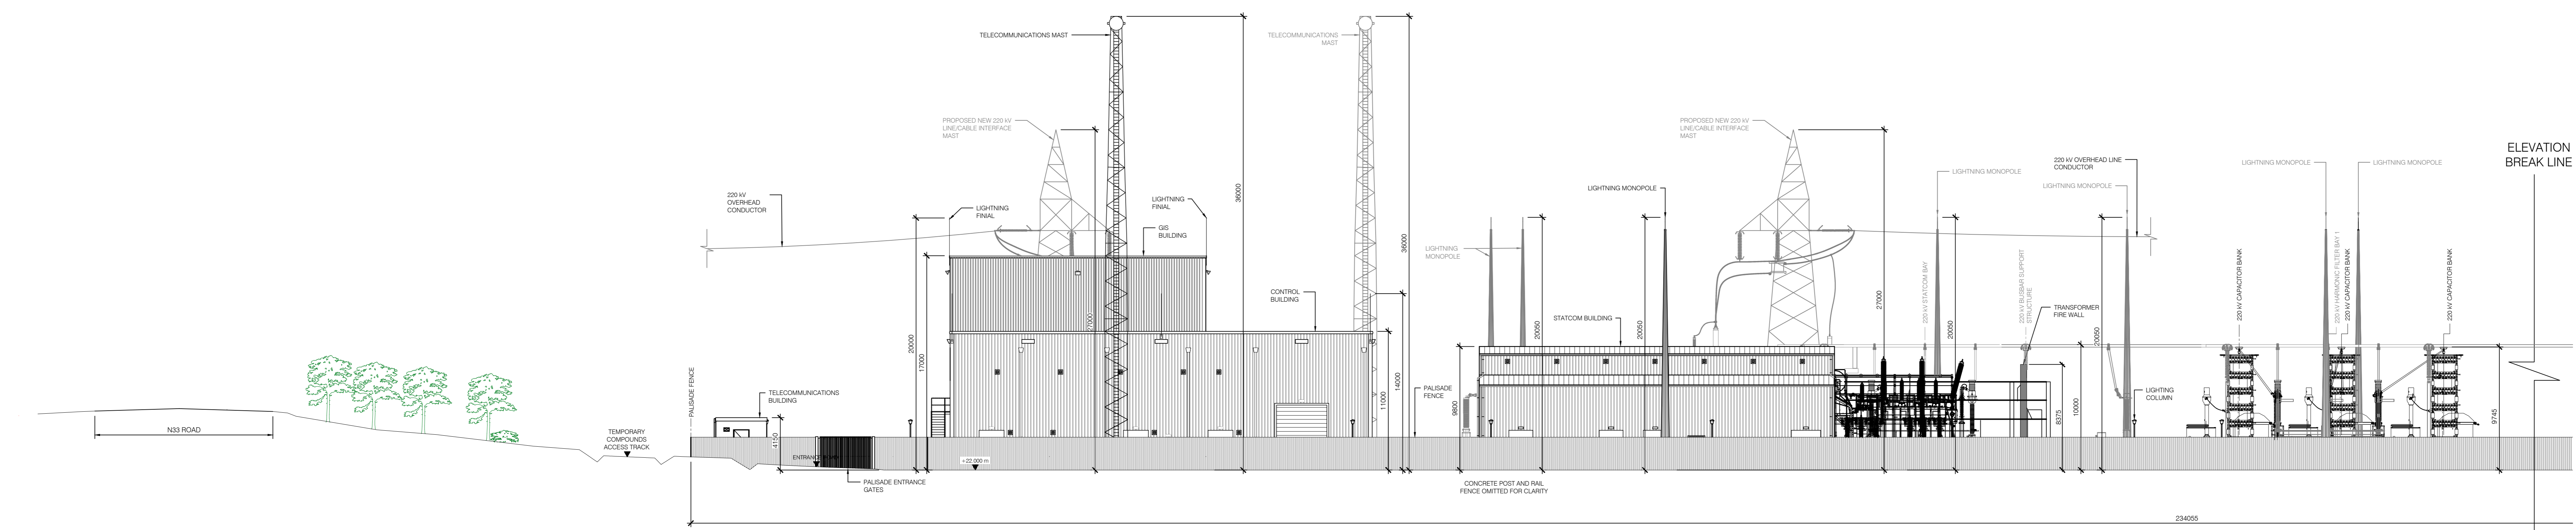

EAST ELEVATION  
SCALE 1:200

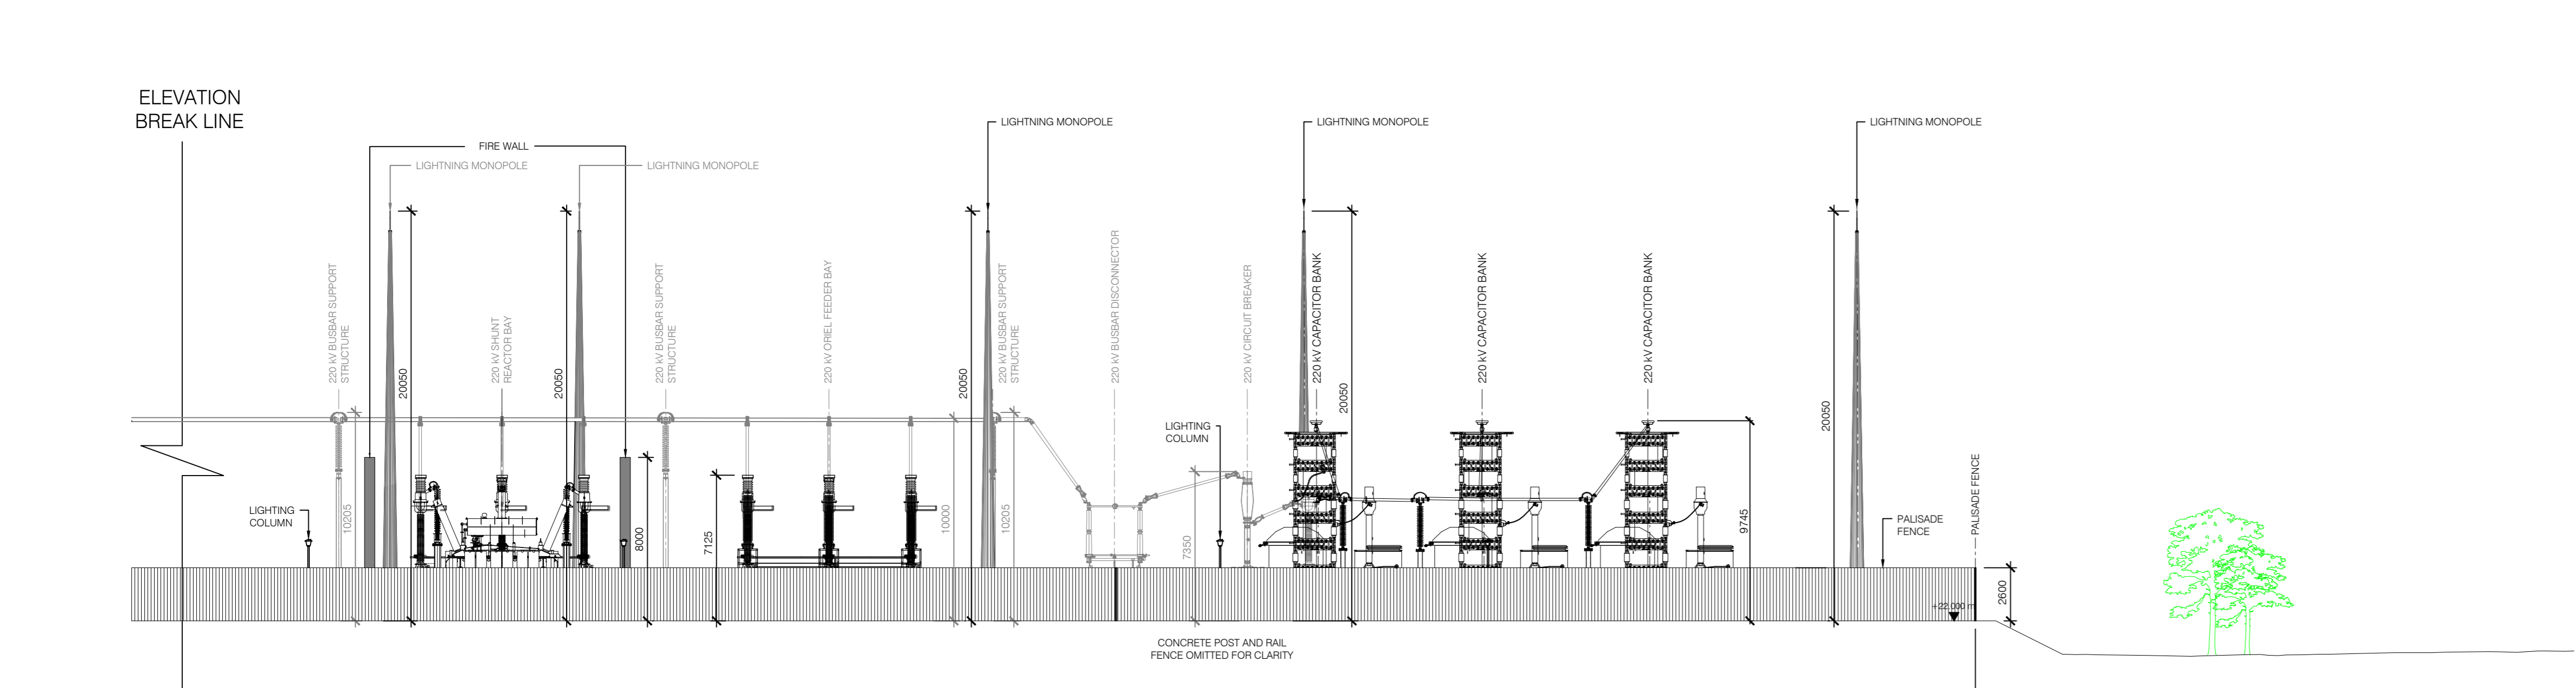

EAST ELEVATION  
SCALE 1:200

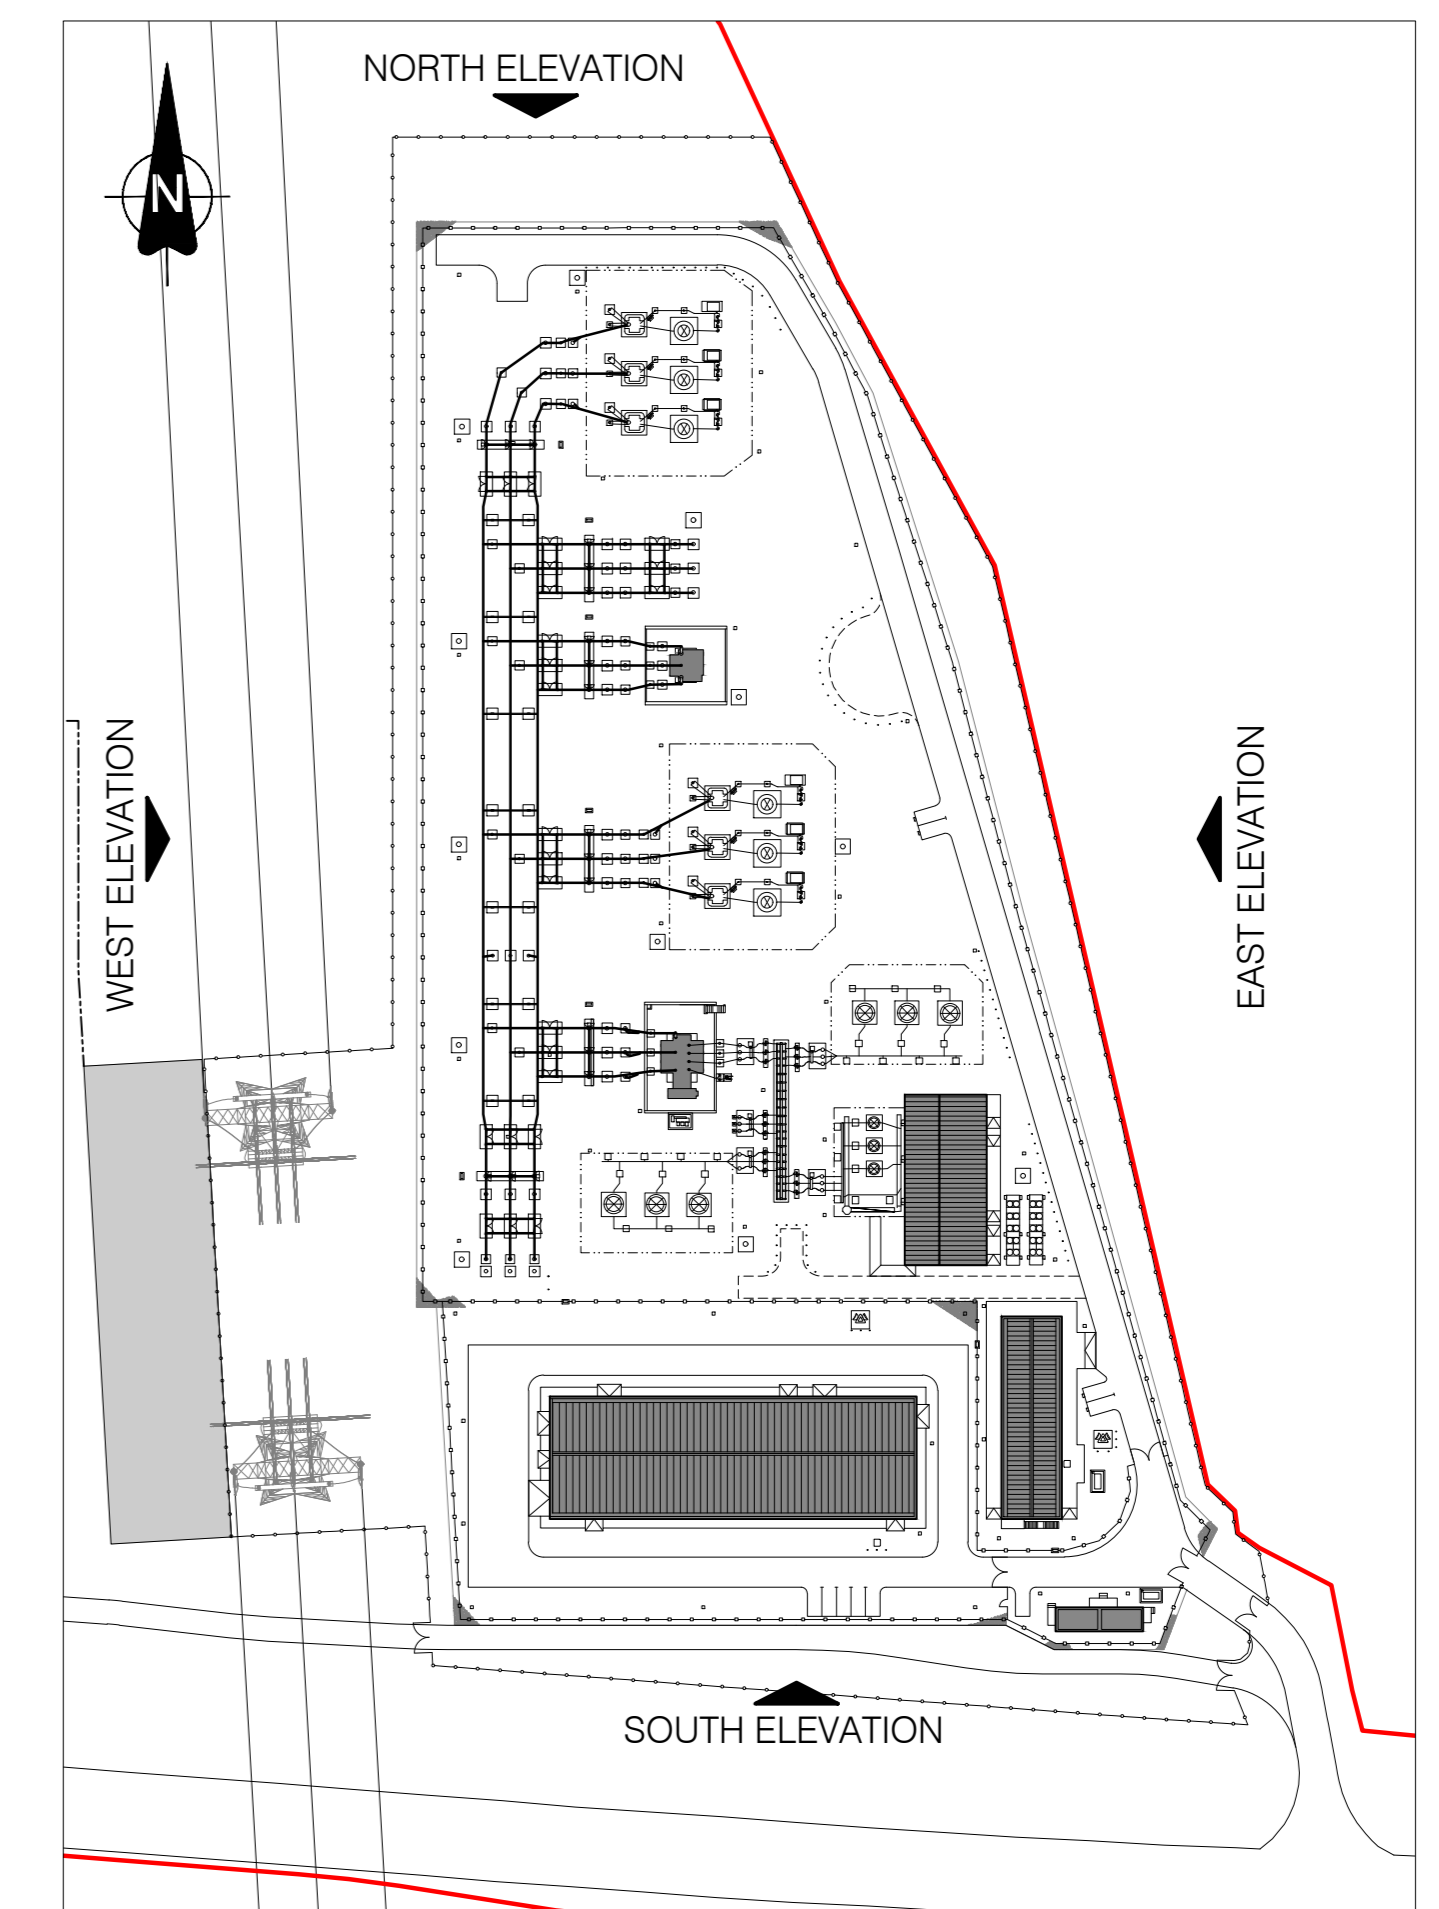

KEY PLAN  
SCALE 1:1250

REV	DATE	REVISION DESCRIPTION	DRN	PROJ	VER	APP
2		PROJECT TITLE REVISED		SB		
1	21.08.24	ISSUED FOR PERMITTING AND CONSTRUCTION. ALL DIMENSIONS TO BE CHECKED AGAINST THE LATEST VERSION OF THE DRAWINGS. ACCESS ROAD TO BE REVISED TO MATCH THE BUILDING FOOTPRINT. CONFORM TO THE LATEST VERSION OF THE DRAWINGS. CONFORM TO THE LATEST VERSION OF THE DRAWINGS.		SB	SB	RH
0	14.12.20	INITIAL VERSION		RK	RH	BP

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PURPOSE OF ISSUE: PRELIMINARY UNLESS INDICATED

CLIENT:  PLANNING  TENDER  CONSTRUCTION  AS-BUILT

CLIENT: Oriel Windfarm Limited

PROJECT: Oriel Wind Farm Project

CONTRACT: ONSHORE SUBSTATION

DRAWING TITLE: PROPOSED COMPOUND 1 AND COMPOUND 2 ELEVATIONS

SHEET 2 OF 2

PRODUCTION UNIT: Civil, Environmental and Renewable Engineering

DRAWN	PRODUCED	VERIFIED	APPROVED	APPROVAL DATE
S. Burtin	S. Burtin	A. Heine	J. McLaughlin	23/02/2024

CLIENT REF	NO. OF SHEETS	SIZE	SCALE
TC23815	1	A0	1:200

DRAWING NUMBER	SHEET	REV
PE605-D027-038-008-002		